PROJECT INFORMATION

PROJECT ADDRESS: 5879 CRENSHAW BLVD, LOS ANGELES, CA 90043

LEGAL DESCRIPTION:

ASSESSOR PARCEL NO. (APN):	4005003012
TRACT:	TR 2095
MAP REFERENCE:	M B 23-22
LOT:	FR 68
MAP SHEET:	105B185
BLOCK:	None
PIN #:	105B185 58

PROJECT OWNER AND ADDRESS:

5879 CRENSHAW LLC

4615 WINNETKA CIR, WOODLAND HILLS, CA 91364

PLANNING AND ZONING INFORMATION:

PROPOSED:

ZONING:

LOT AREA:

100% PRIVATELY FUNDED 34-UNITS 4-STORY MIXED USE APARTMENT BUILDING C2-2D-SP 8,419.2 (sq ft) 60 47'-6"

2017 LOS ANGELES BUILDING CODE (LABC)

CITY OF LOS ANGELES

BUILDING CODE INFORMATION:

ALLOWABLE HEIGHT PER SP:

PROPOSED HEIGHT:

GOVERNING JUR APPLICABLE COE GROUP OF OCCU TYPE OF CONSTE SPRINKLER: BUILDING RATE: EXTERIOR WALLS	DES: IPANCY: RUCTION:
BUILDING SUM	MARY:
PROJECT INFORM STORE APARTME 09 UNITS	
24 UNITS 01 UNIT RETAIL STORE	SINGLE

R-2 TYPE V-A YES / NFPA 13R SPRINKLER ONE HR. RATED ONE HR. RATED 34-UNITS 4-STORY MIXED USE WITH 1365 SQ.FT. RETAIL

FAR SUMMARY:

ALLOWABLE FAR: 1.5:1, (BY RIGHT) = 8,419.2 (sq ft) / 1.5 = 12,628.8 4.25:1, (PER TIER 4 IN COMMERCIAL ZONES) = 8,419.2 (sq ft) / 4.25 = 35,781.6 PROPOSED FAR: BUILDING AREA INCLUDING RETAIL STORE = 27,576.0 27,576.0 < 35,781.6 **PARKING SUMMARY:**

AUTOMOBILE PARKING SUMMERY :

REQUIRED: NO AUTOMOBILE PARKING PER TIER4

PROPOSED: NO AUTOMOBILE PARKING

RESIDENTIAL BICYCLE PARKING SUMMERY :

REQUIRED: 1 PARKING PER UNIT LONG TERM AND 1 PARKING PER 10 UNITS (MIN. 2 PARKING) SHORT TERM.

PROPOSED:	LONG TERM	SHORT TERM
APARTMENT	34	04
COMMERCIAL	02	02
TOTAL	36	06 = 42

TOC AFFORDABLE HOUSING SUMMARY:

NUMBER OF UNITS:

LOT SIZE: 8,419.2 (sq ft) MINIMUM AREA PER DWELLING UNIT: 400 UNITS ALLOWED BY RIGHT (PER LAMC): 8,419.2 (sq ft) / 400 = 21.048 = 22 UNITS BASE DENSITY: 22 UNITS PER TOC TIER 4: 22 UNITS x 1.8 = 39.6 = 40 PROPOSED: 34 UNITS

AFFORDABLE UNITS SUMMERY: Market Rate


Very Low Income:	
TOTAL # of Units Proposed:	

Number of Density Increase Units: Percent Density Increase Requested: Percent of Affordable Set Aside:

27	UNITS
7	UNITS
34	UNITS
4.0	

12 UNITS 1.54% 20%



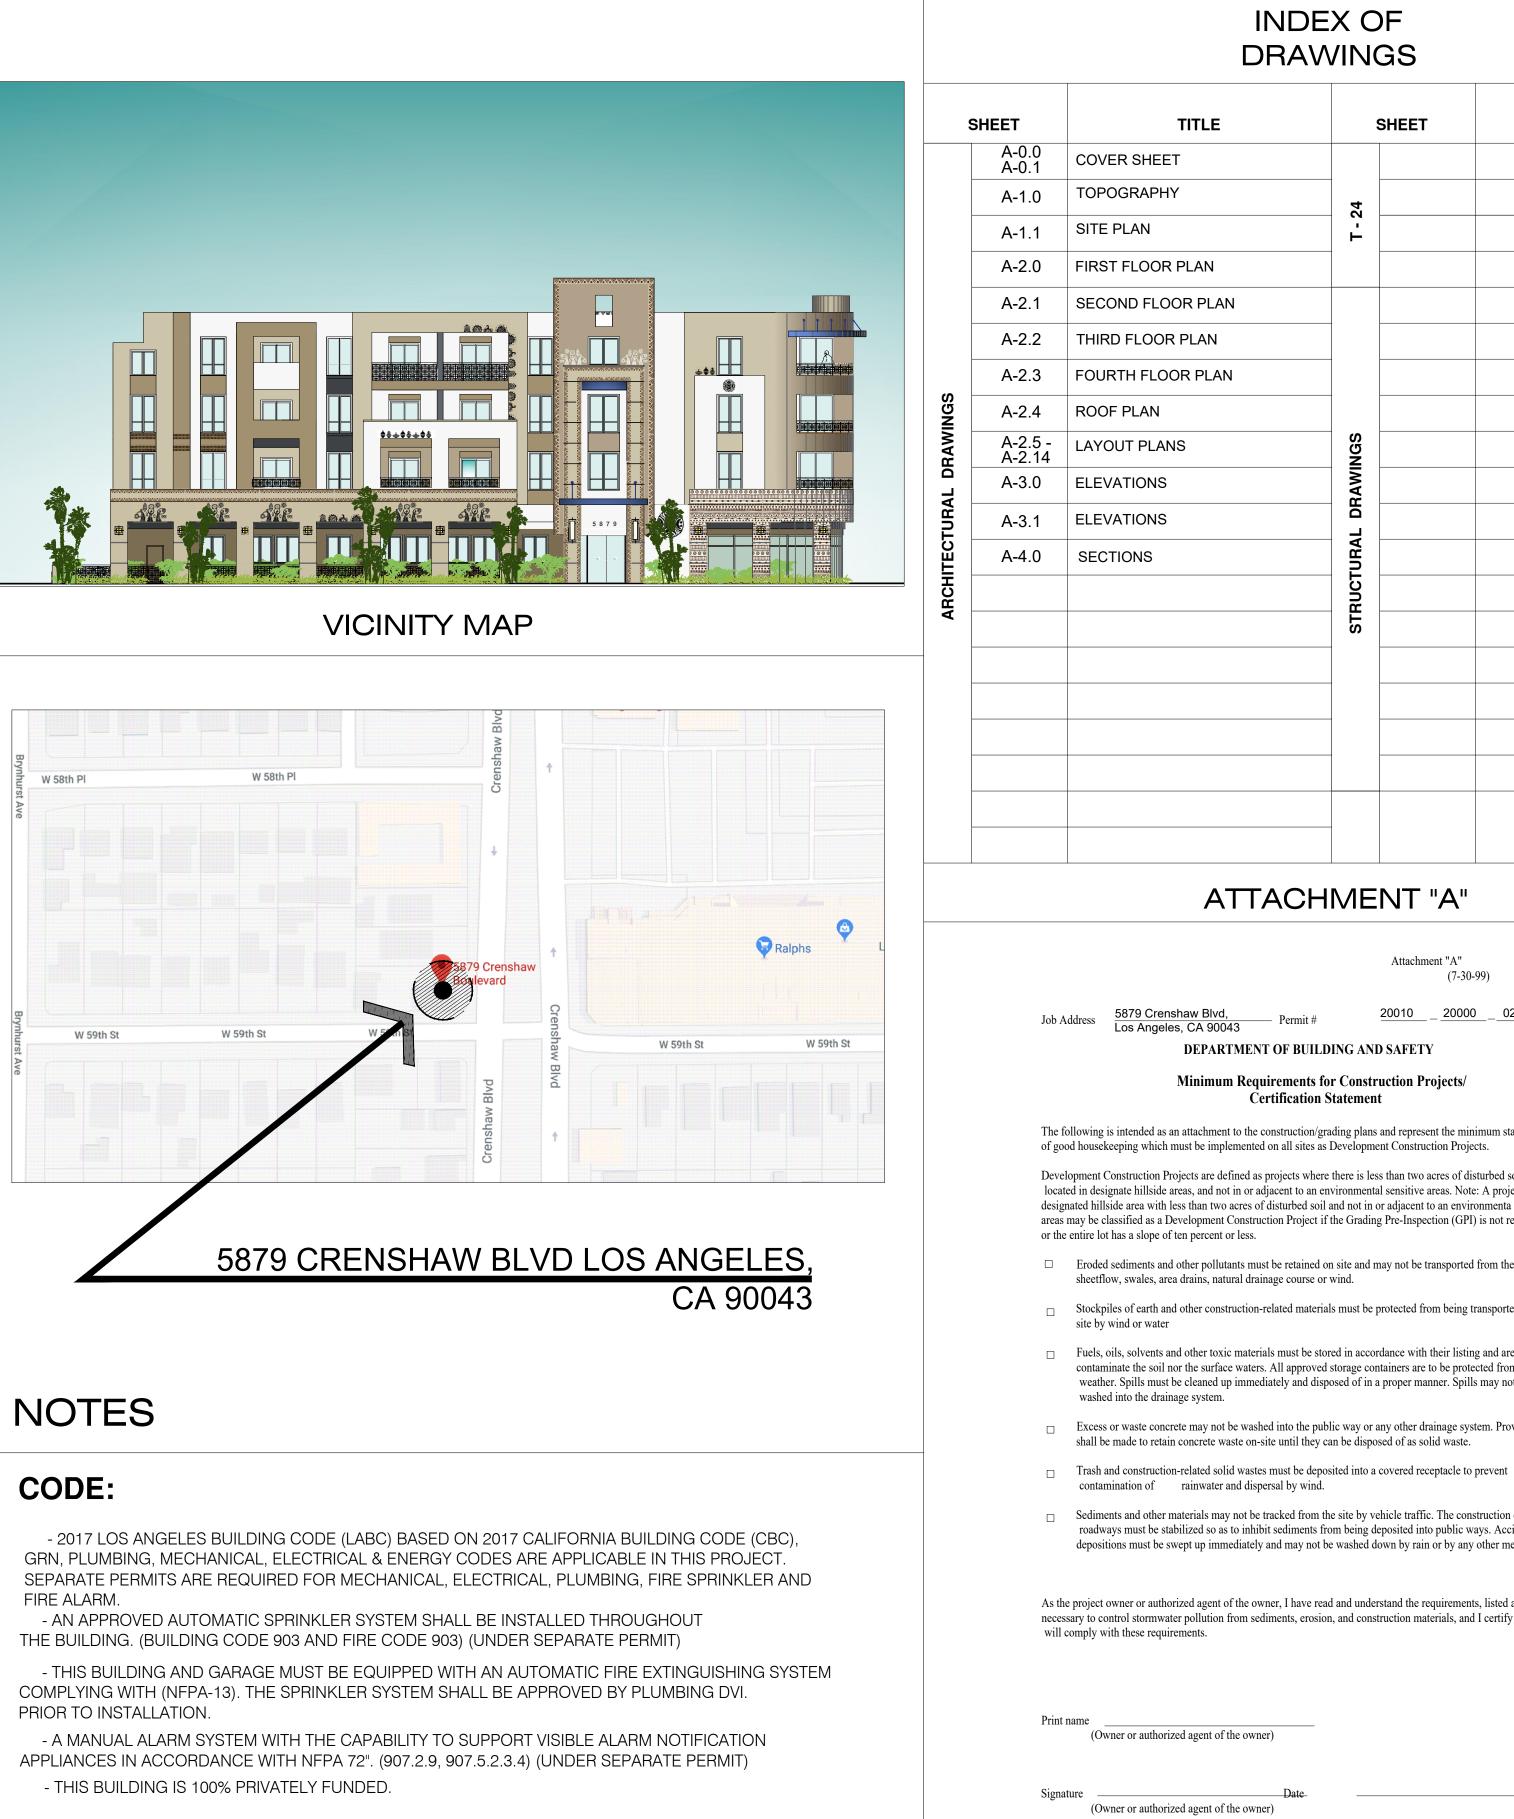

PROPOSED MIXED USE **34-UNITS APARTMENT BUILDING & 1365 SQ.FT COMMERCIAL**

5879 Crenshaw Blvd, Los Angeles, CA 90043

IFM[] Design & eng CONSTRUCTION

19730 VENTURA BLVD. #5 WOODLAND HILLS, CALIFORNIA 91364 TEL.: (818) 932-0393 FAX: (818) 932-0419

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PROJECT:

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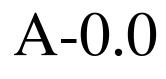
SHEET TITLE:

COVER SHEET

REVISION: NO. DATE BY - - -

SCALE : DESIGN & DRAWN : FMI 03.10.21 DATE : JOB NUMBER :

SHEET



D	ESIGN BY :
NAME	FMI DESIGN, ENGINEERING & CONSRTUCTION
ADD	. 19730 VENTURA BLVD., #5
	WOODLAND HILLS, CA 91364 : (818) 231-8475
FAX. E-MAIL	: (818) 932-0419 : yagh@aol.com
SI	
NAME	ZHANG YUAN NI : ph.d., p.e.
ADD	. 8823 GARVEY AVE #B 1/2 ROSEMEAD, CA 91770
TEL. FAX.	: (626) 298-1828 : (626) 571-4040
E-MAIL	: zyniengineering@gmail.com
El	IERGY CONSULTANT :
NAME	: PERFECT DESIGN & ENGINEERING, INC.
ADD	. 2416 W. VALLEY BLVD. ALHAMBRA, CA 91803
TEL. FAX.	: (626) 289-8808
	: (626) 289-4913 : PERFECTAAA@aol.com
	DIL ENGINEER :
NAME	: ADVANCED GEOTECHNIQUES
ADD	. 16555 SHERMAN WAY,SUITE A-VAN NUYS
TEL.	CA 91406 :
FAX.	. 818-785-5244
E-MAIL	: tj@agigeo.com
SL	JRVEYOR :
NAME	: MOLAI LAND & DESIGN
ADD	. 24308 BURBANK BLVD WOODLAND HILLS, CA 91367
TEL. FAX.	818-325-9225
	: MOLAI22@YAHOO.COM
LA	NDSCAPE ARCHITECT :
NAME	:
ADD	:
TEL. FAX.	:
E-MAIL	:
NAME	
ADD	:
TEL.	:
FAX.	:
E-MAIL	:
	ECHANICAL ENGINEER :
TEL.	:
FAX.	:
E-MAIL	··
GI	EOTECHNICAL ENGINEER :
NAME	:

TITLE

TEL


FAX.

E-MAIL

ELEVATION KEY NOTES	
1 CLASS "A" ROOF	
2 STUCCO	
3 DOWNSPOUT	
4 GUARDRAIL	

EAST ELEVATION

SCALE: 1/8"= 1'-0"

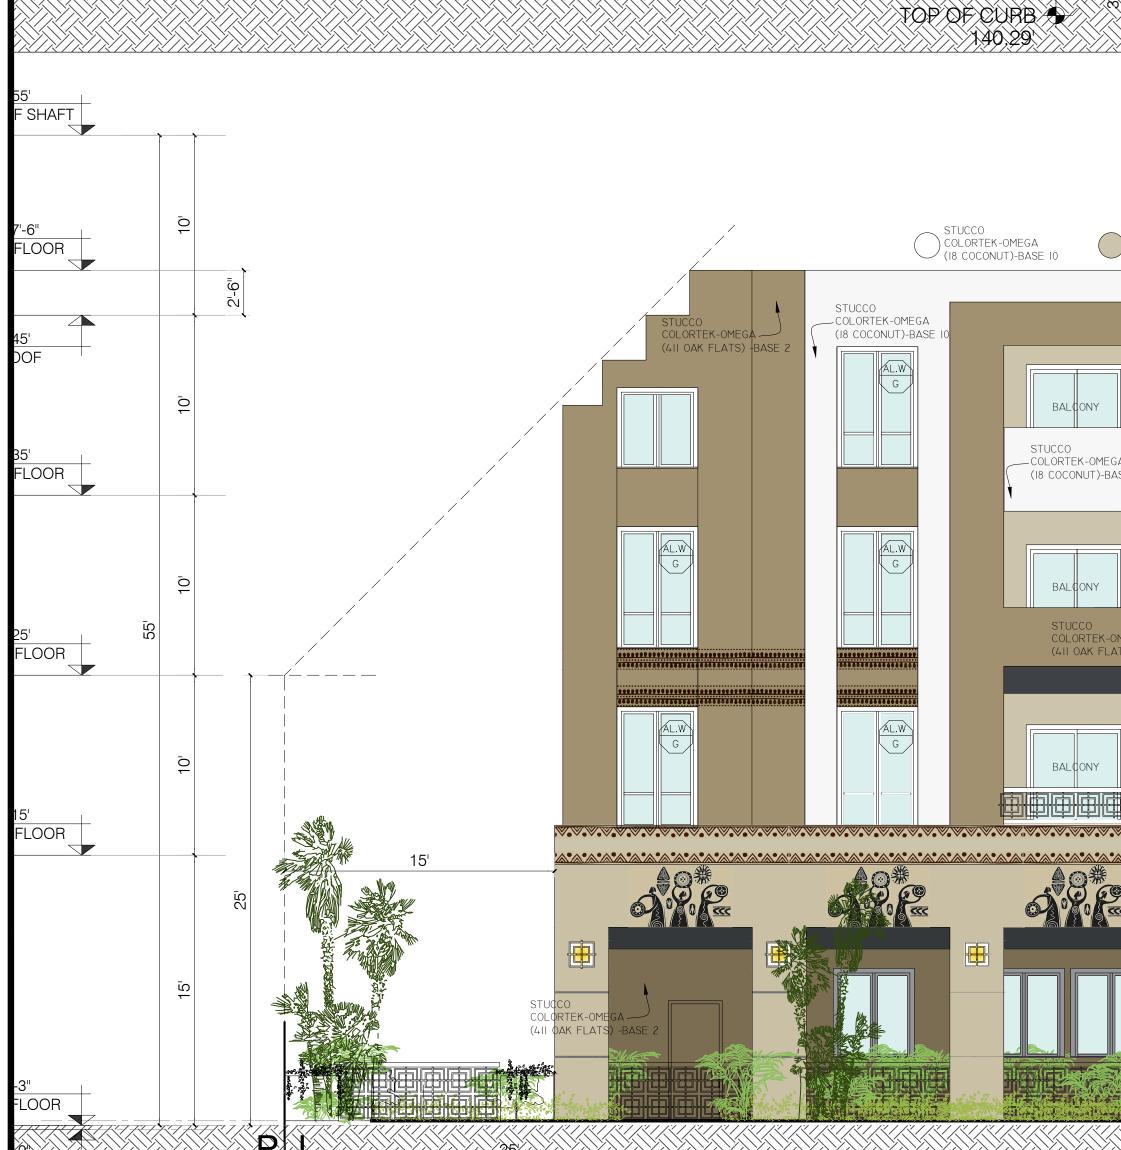



SOUTH ELEVATION

+

SCALE: 1/8"= 1'-0"	
STUCCO COLORTEK-OMEGA (437 ROUGH KHAKI)-BASE 2 STUCCO COLORTEK-OMEGA (411 OAK FLATS)-BASE 2	
STUCCO COLORTEK-OMEGA (437 ROUGH KHAKI)-BASE 2 BALCONY BALCONY BALCONY BALCONY	
OMEGA ATS) - BASE Z I I I I I I I I I I I I I I I I I I I	





DESIGN BY:

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OWNER :

RAMI BEMMOSHE 4615 WINNETKA CIR, WOODLAND HILLS, CA 91364

PROJECT :

6506-6510 S MAIN ST, LOS ANGELES, CA 90003

SHEET TITLE:

ELEVATIONS

REVISION: NO. DATE BY - - -

SCALE :
DESIGN & DRAWN :
DATE :
JOB NUMBER :

1/8"=1'-0" FMI 02.11.21

A-3.3





PROJECT :

6506-6510 S MAIN ST, LOS ANGELES, CA 90003

SHEET TITLE:


ELEVATIONS

REVISION: NO. DATE BY - - -

SCALE : DESIGN & DRAWN : DATE : JOB NUMBER :

1/8"=1'-0" FMI 02.11.21

A-3.2

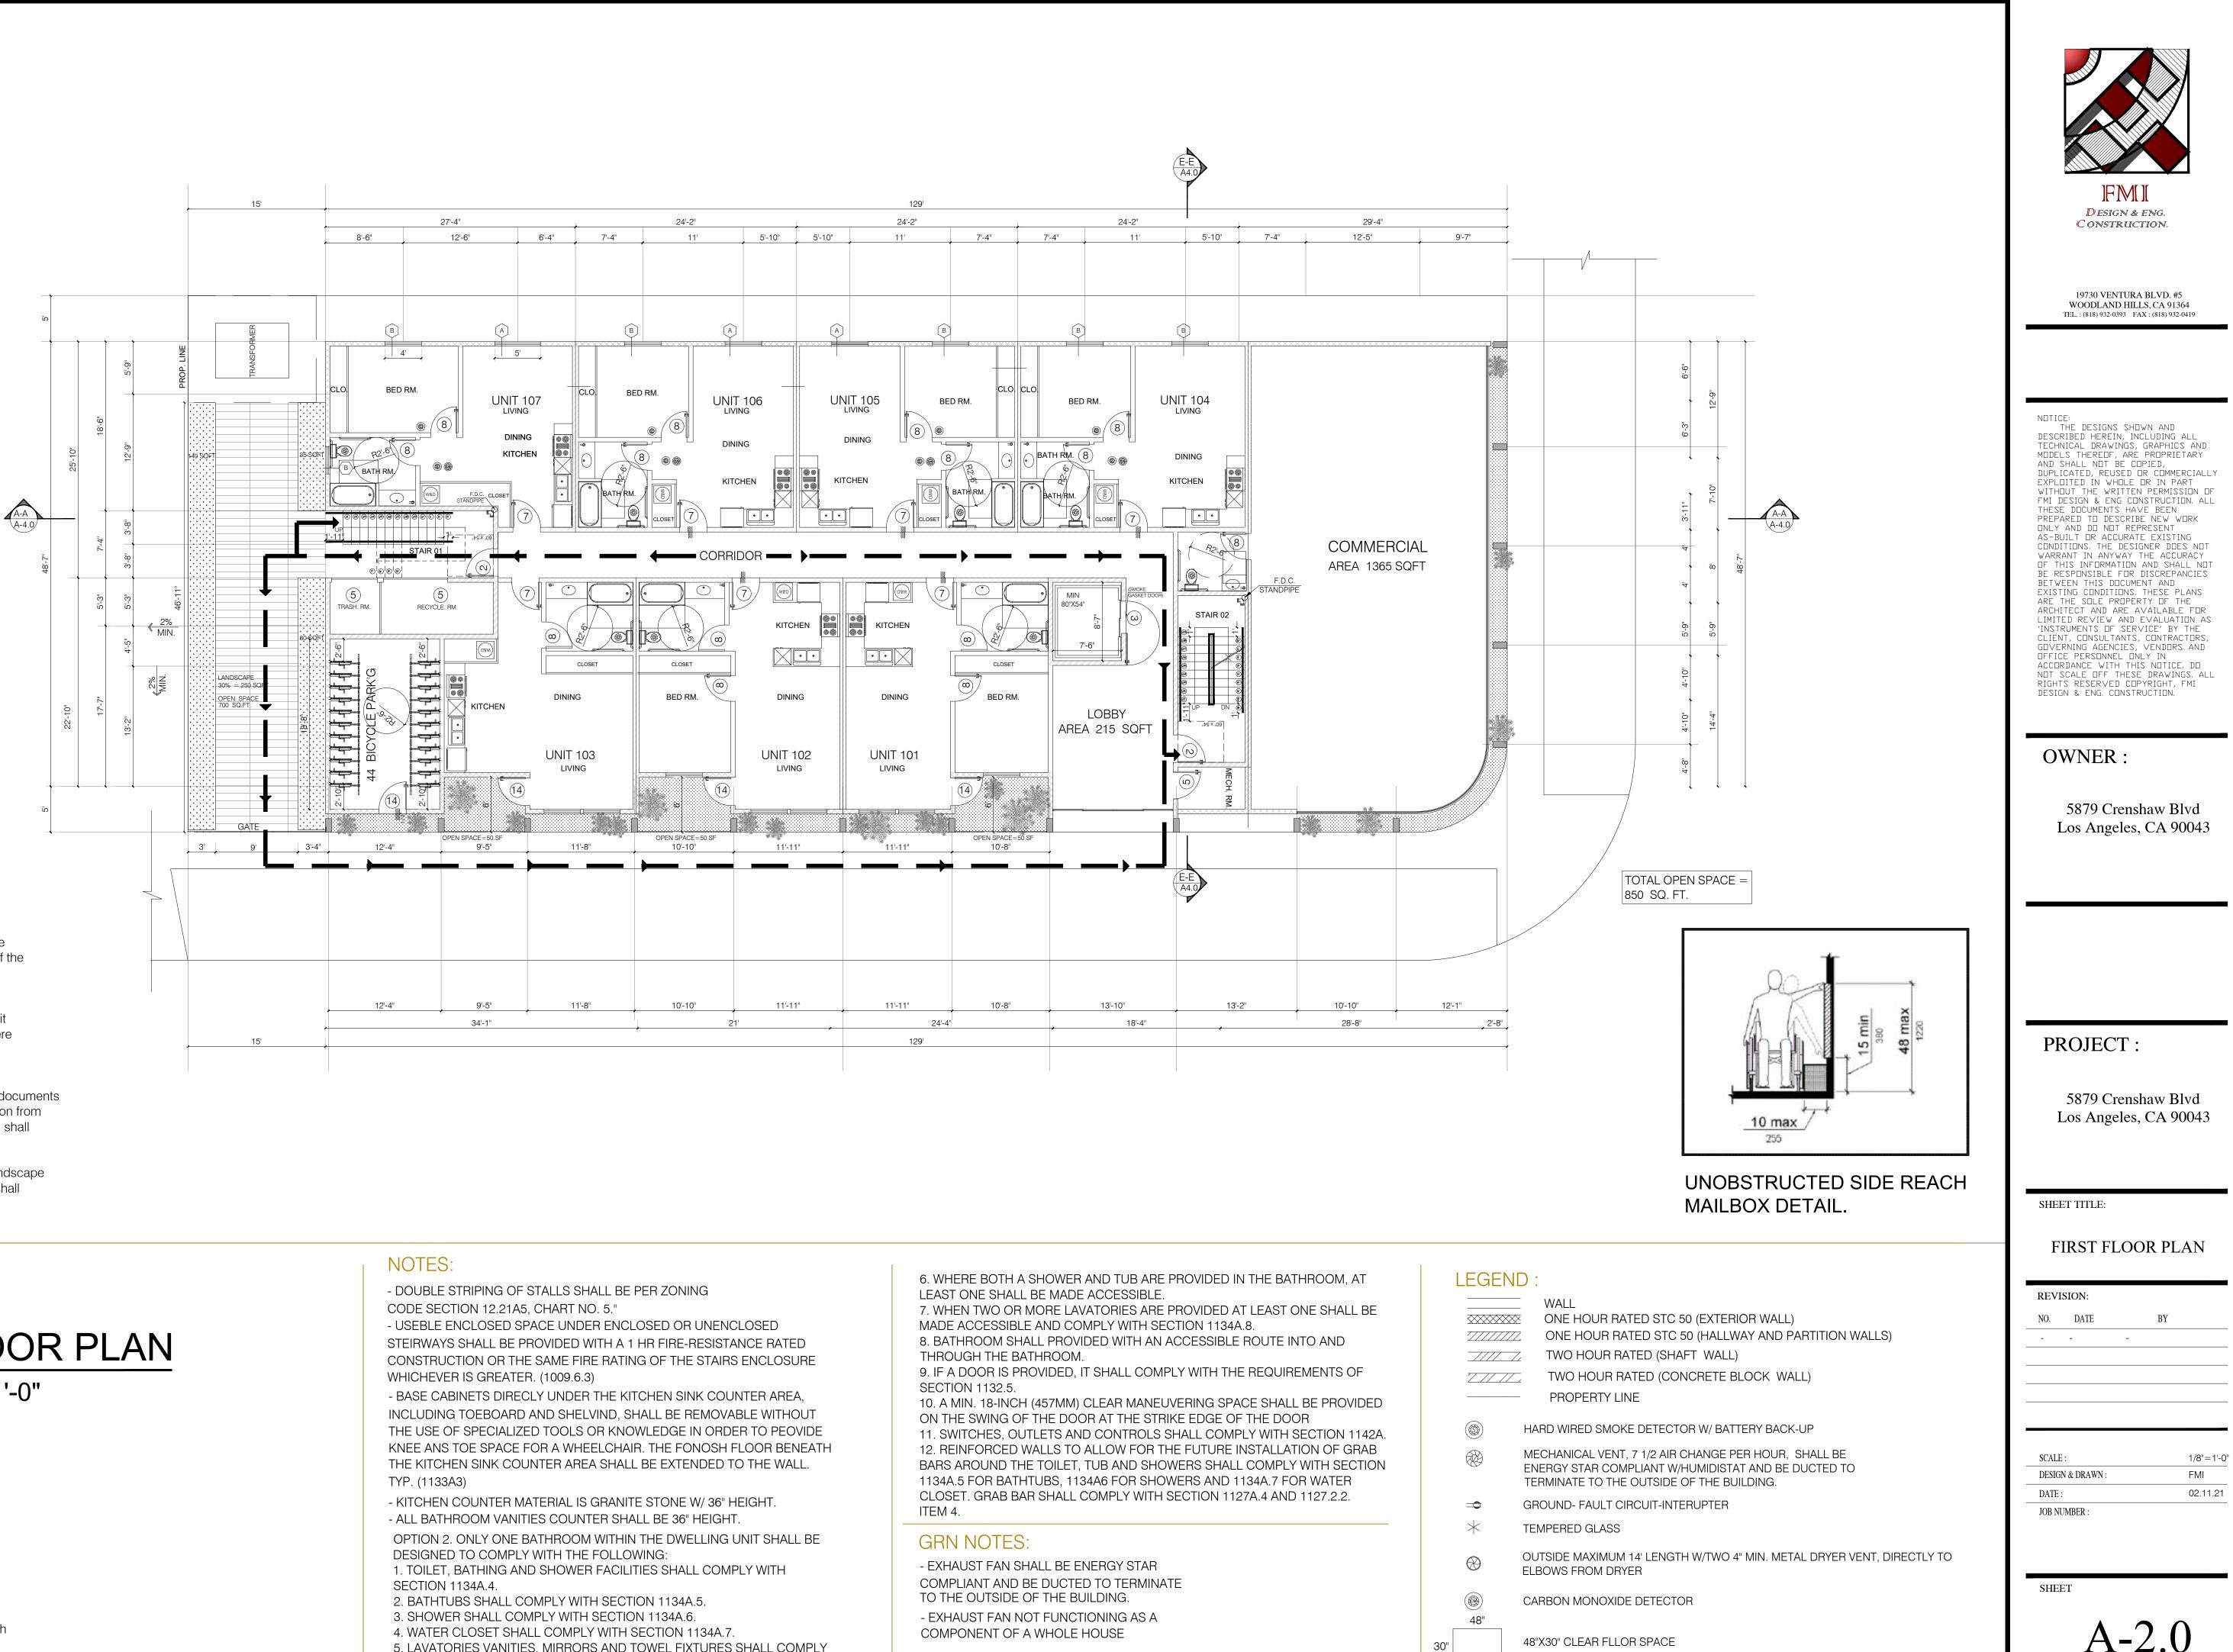

GRN NOTES:

g. sufficient capacity to simultaneously charge all Add note to plans: "The electrical system shall have designated EV spaces at the full rated amperage of the h. circuit directory shall identify the overcurrent Add note to plans: "The service panel or subpanel is required."

minimum branch circuit. A separate electrical permit EVSE. Plan design shall be based upon a 40-ampere protective device space(s) reserved for future EV charging purposes as EV CAPABLE in accordance

with the Los Angeles Electrical Code." 11. Add note to plans: "A copy of the construction documents or a comparable document indicating the information from Energy Code Sections 110.10(b) through 110.10(c) shall be provided to the occupant."

(Energy Code §110.10(d))

18. Add note to plans: "For projects that include landscape work, the Landscape Certification, Form GRN 12, shall be completed prior to final inspection approval." (State Assembly Bill No. 1881)



FIRE EXTINGUISHERS


- PORTABLE FIRE EXTINGUISHERS SHALL BE PROVIDED: (SIZE AND DISTRIBUTION SHALL BE IN ACCORDANCE WITH SEC. 906.1-906.4).


W/D:

- WASHER AND DRYE SHALL BE FRONT LOAD (if conter is provided, shall be at 34" max. height with 27" min. knee clear at 19" min. deep, typical) COMPLY WITH CODE SECTION (1127.A.10)

5. LAVATORIES VANITIES, MIRRORS AND TOWEL FIXTURES SHALL COMPLY WITH SECTION 1134A.8.

- CONTROLLED BY A HUMIDITY CONTROL.

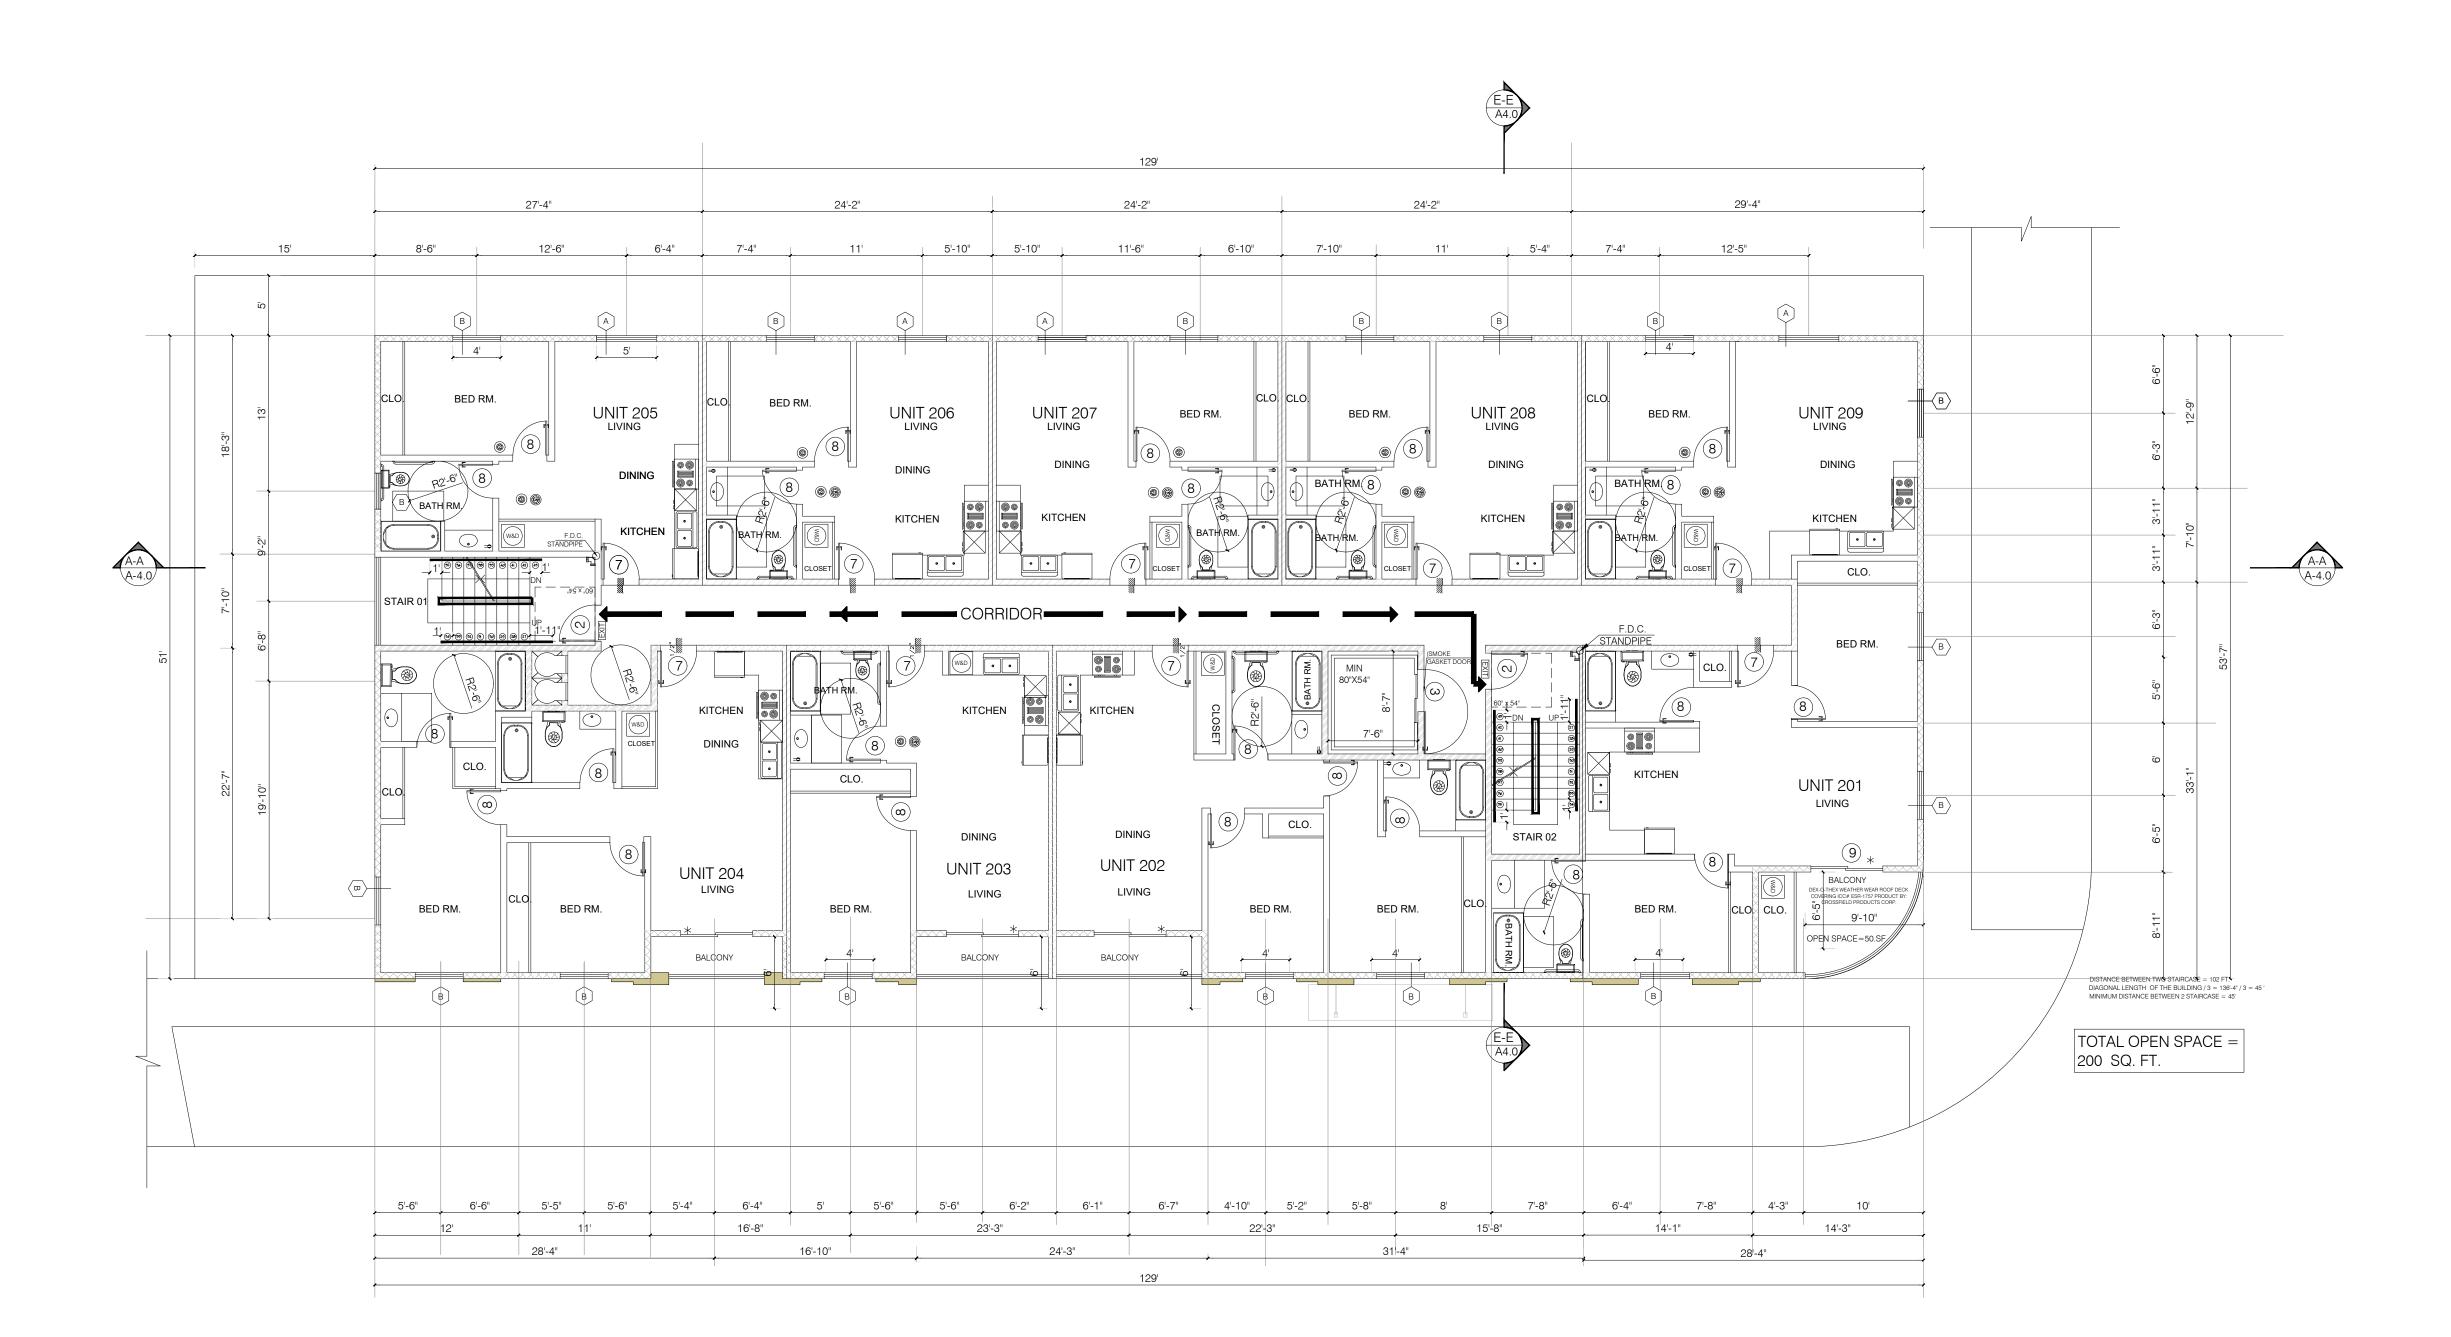

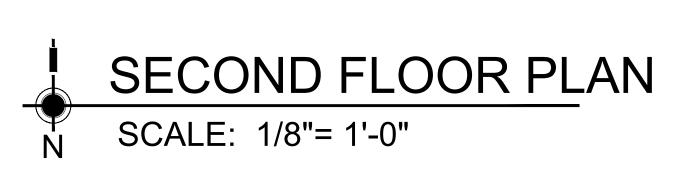

FIRE EXTINGUISHERS

- PORTABLE FIRE EXTINGUISHERS SHALL BE PROVIDED: (SIZE AND DISTRIBUTION SHALL BE IN ACCORDANCE WITH SEC. 906.1-906.4).

W/D:

- WASHER AND DRYE SHALL BE FRONT LOAD (if conter is provided, shall be at 34" max. height with 27" min. knee clear at 19" min. deep, typical) COMPLY WITH CODE SECTION (1127.A.10)

EXIT ACCESS

- EXIT ACCESS DOORWAYS, STAIRWAYS OR RAMPS SHALL BE PLACED A DISTANCE APART> $\binom{1}{2}$ THE LENGTH OF THE OVERALL DIAGONAL OF THE AREA TO BE SERVED (CBC 1007.1.1) ALLOWABLE: 131' / 2 = 65.5'PROPOSED: 64'-0"

NOTES:

- DOUBLE STRIPING OF STALLS SHALL BE PER ZONING CODE SECTION 12.21A5, CHART NO. 5." - USEBLE ENCLOSED SPACE UNDER ENCLOSED OR UNENCLOSED STEIRWAYS SHALL BE PROVIDED WITH A 1 HR FIRE-RESISTANCE RATED CONSTRUCTION OR THE SAME FIRE RATING OF THE STAIRS ENCLOSURE WHICHEVER IS GREATER. (1009.6.3)

- BASE CABINETS DIRECLY UNDER THE KITCHEN SINK COUNTER AREA, INCLUDING TOEBOARD AND SHELVIND, SHALL BE REMOVABLE WITHOUT THE USE OF SPECIALIZED TOOLS OR KNOWLEDGE IN ORDER TO PEOVIDE KNEE ANS TOE SPACE FOR A WHEELCHAIR. THE FONOSH FLOOR BENEATH THE KITCHEN SINK COUNTER AREA SHALL BE EXTENDED TO THE WALL. TYP. (1133A3)

- KITCHEN COUNTER MATERIAL IS GRANITE STONE W/ 36" HEIGHT. - ALL BATHROOM VANITIES COUNTER SHALL BE 36" HEIGHT.

OPTION 2. ONLY ONE BATHROOM WITHIN THE DWELLING UNIT SHALL BE DESIGNED TO COMPLY WITH THE FOLLOWING: 1. TOILET, BATHING AND SHOWER FACILITIES SHALL COMPLY WITH SECTION 1134A.4.

2. BATHTUBS SHALL COMPLY WITH SECTION 1134A.5. 3. SHOWER SHALL COMPLY WITH SECTION 1134A.6. 4. WATER CLOSET SHALL COMPLY WITH SECTION 1134A.7. 5. LAVATORIES VANITIES, MIRRORS AND TOWEL FIXTURES SHALL COMPLY

WITH SECTION 1134A.8.

6. WHERE BOTH A SHOWER AND TUB ARE PROVIDED IN THE BATHROOM, AT LEAST ONE SHALL BE MADE ACCESSIBLE.

7. WHEN TWO OR MORE LAVATORIES ARE PROVIDED AT LEAST ONE SHALL BE MADE ACCESSIBLE AND COMPLY WITH SECTION 1134A.8.

8. BATHROOM SHALL PROVIDED WITH AN ACCESSIBLE ROUTE INTO AND THROUGH THE BATHROOM.

9. IF A DOOR IS PROVIDED, IT SHALL COMPLY WITH THE REQUIREMENTS OF SECTION 1132.5.

10. A MIN. 18-INCH (457MM) CLEAR MANEUVERING SPACE SHALL BE PROVIDED ON THE SWING OF THE DOOR AT THE STRIKE EDGE OF THE DOOR

11. SWITCHES, OUTLETS AND CONTROLS SHALL COMPLY WITH SECTION 1142A. 12. REINFORCED WALLS TO ALLOW FOR THE FUTURE INSTALLATION OF GRAB BARS AROUND THE TOILET, TUB AND SHOWERS SHALL COMPLY WITH SECTION 1134A.5 FOR BATHTUBS, 1134A6 FOR SHOWERS AND 1134A.7 FOR WATER CLOSET. GRAB BAR SHALL COMPLY WITH SECTION 1127A.4 AND 1127.2.2. ITEM 4.


GRN NOTES:

- EXHAUST FAN SHALL BE ENERGY STAR COMPLIANT AND BE DUCTED TO TERMINATE TO THE OUTSIDE OF THE BUILDING. - EXHAUST FAN NOT FUNCTIONING AS A COMPONENT OF A WHOLE HOUSE VENTILATION SYSTEM, MUST BE CONTROLLED BY A HUMIDITY CONTROL.

30"

LEGEND

777	TWO HOUR RATED (CONCRETE BLOCK WALL)
	PROPERTY LINE
	HARD WIRED SMOKE DETECTOR W/ BATTERY BACK-UP
	MECHANICAL VENT, 7 1/2 AIR CHANGE PER HOUR, SHALL BE ENERGY STAR COMPLIANT W/HUMIDISTAT AND BE DUCTED TO TERMINATE TO THE OUTSIDE OF THE BUILDING.
⇒	GROUND- FAULT CIRCUIT-INTERUPTER
*	TEMPERED GLASS
\bigotimes	OUTSIDE MAXIMUM 14' LENGTH W/TWO 4" MIN. METAL DRYER VENT, DIRECTLY TO ELBOWS FROM DRYER
	CARBON MONOXIDE DETECTOR
48"	48"X30" CLEAR FLLOR SPACE

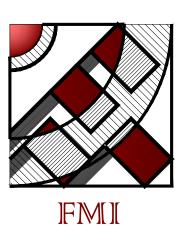

Design & eng. CONSTRUCTION.

19730 VENTURA BLVD. #5 WOODLAND HILLS, CA 91364 TEL. : (818) 932-0393 FAX : (818) 932-0419

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SHEET TITLE:


SECOND FLOOR PLAN


REVISION: NO. DATE BY - - -

SCALE : DESIGN & DRAWN : DATE : JOB NUMBER :

1/8"=1'-0" FMI 02.11.21

A-2.1

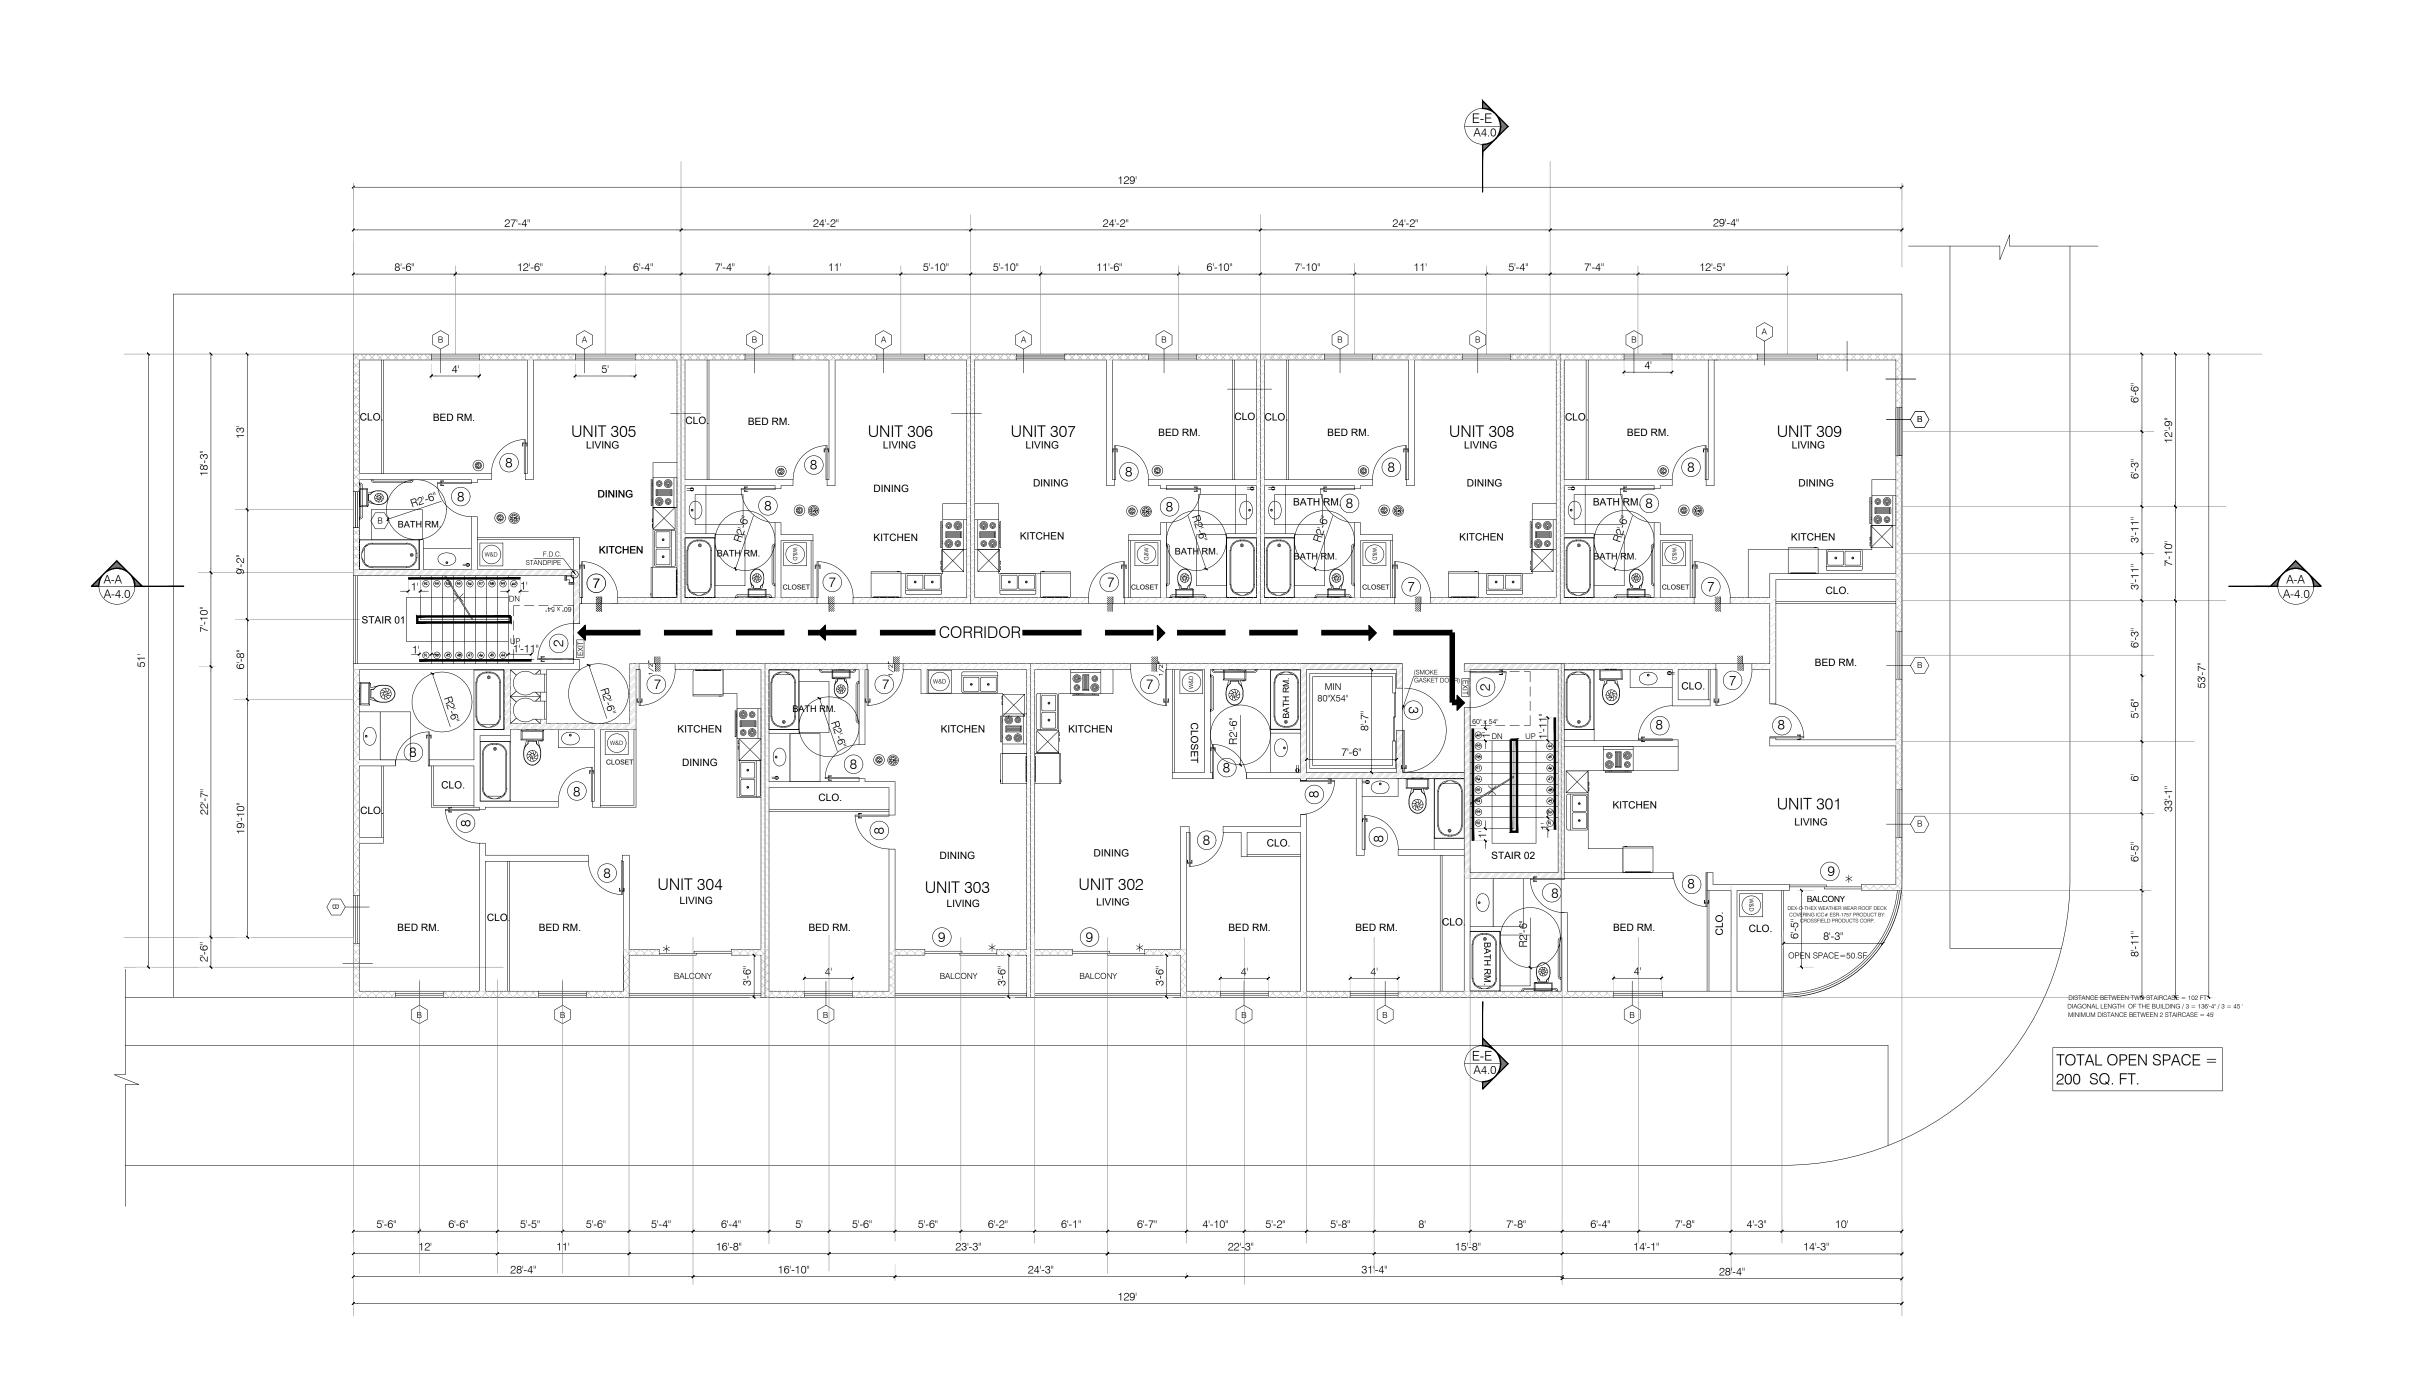

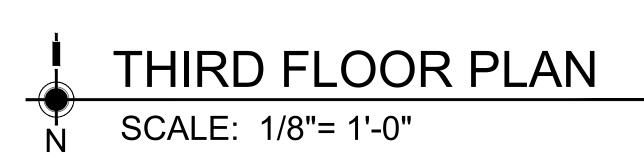

FIRE EXTINGUISHERS

- PORTABLE FIRE EXTINGUISHERS SHALL BE PROVIDED: (SIZE AND DISTRIBUTION SHALL BE IN ACCORDANCE WITH SEC. 906.1-906.4).

W/D:

- WASHER AND DRYE SHALL BE FRONT LOAD (if conter is provided, shall be at 34" max. height with 27" min. knee clear at 19" min. deep, typical) COMPLY WITH CODE SECTION (1127.A.10)

EXIT ACCESS

- EXIT ACCESS DOORWAYS, STAIRWAYS OR RAMPS SHALL BE PLACED A DISTANCE APART> $(\frac{1}{2})$ THE LENGTH OF THE OVERALL DIAGONAL OF THE AREA TO BE SERVED (CBC 1007.1.1) ALLOWABLE: 131' / 2 = 65.5'PROPOSED: 64'-0"

NOTES:

- DOUBLE STRIPING OF STALLS SHALL BE PER ZONING CODE SECTION 12.21A5, CHART NO. 5." - USEBLE ENCLOSED SPACE UNDER ENCLOSED OR UNENCLOSED STEIRWAYS SHALL BE PROVIDED WITH A 1 HR FIRE-RESISTANCE RATED CONSTRUCTION OR THE SAME FIRE RATING OF THE STAIRS ENCLOSURE WHICHEVER IS GREATER. (1009.6.3)

- BASE CABINETS DIRECLY UNDER THE KITCHEN SINK COUNTER AREA, INCLUDING TOEBOARD AND SHELVIND, SHALL BE REMOVABLE WITHOUT THE USE OF SPECIALIZED TOOLS OR KNOWLEDGE IN ORDER TO PEOVIDE KNEE ANS TOE SPACE FOR A WHEELCHAIR. THE FONOSH FLOOR BENEATH THE KITCHEN SINK COUNTER AREA SHALL BE EXTENDED TO THE WALL. TYP. (1133A3)

- ALL BATHROOM VANITIES COUNTER SHALL BE 36" HEIGHT.

OPTION 2. ONLY ONE BATHROOM WITHIN THE DWELLING UNIT SHALL BE DESIGNED TO COMPLY WITH THE FOLLOWING: 1. TOILET, BATHING AND SHOWER FACILITIES SHALL COMPLY WITH SECTION 1134A.4.

2. BATHTUBS SHALL COMPLY WITH SECTION 1134A.5. 3. SHOWER SHALL COMPLY WITH SECTION 1134A.6.

4. WATER CLOSET SHALL COMPLY WITH SECTION 1134A.7.

5. LAVATORIES VANITIES, MIRRORS AND TOWEL FIXTURES SHALL COMPLY

WITH SECTION 1134A.8.

- KITCHEN COUNTER MATERIAL IS GRANITE STONE W/ 36" HEIGHT.

6. WHERE BOTH A SHOWER AND TUB ARE PROVIDED IN THE BATHROOM, AT LEAST ONE SHALL BE MADE ACCESSIBLE.

7. WHEN TWO OR MORE LAVATORIES ARE PROVIDED AT LEAST ONE SHALL BE MADE ACCESSIBLE AND COMPLY WITH SECTION 1134A.8.

8. BATHROOM SHALL PROVIDED WITH AN ACCESSIBLE ROUTE INTO AND THROUGH THE BATHROOM.

9. IF A DOOR IS PROVIDED, IT SHALL COMPLY WITH THE REQUIREMENTS OF SECTION 1132.5.

10. A MIN. 18-INCH (457MM) CLEAR MANEUVERING SPACE SHALL BE PROVIDED ON THE SWING OF THE DOOR AT THE STRIKE EDGE OF THE DOOR


11. SWITCHES, OUTLETS AND CONTROLS SHALL COMPLY WITH SECTION 1142A. 12. REINFORCED WALLS TO ALLOW FOR THE FUTURE INSTALLATION OF GRAB BARS AROUND THE TOILET, TUB AND SHOWERS SHALL COMPLY WITH SECTION 1134A.5 FOR BATHTUBS, 1134A6 FOR SHOWERS AND 1134A.7 FOR WATER CLOSET. GRAB BAR SHALL COMPLY WITH SECTION 1127A.4 AND 1127.2.2. ITEM 4.

GRN NOTES:

- EXHAUST FAN SHALL BE ENERGY STAR COMPLIANT AND BE DUCTED TO TERMINATE TO THE OUTSIDE OF THE BUILDING. - EXHAUST FAN NOT FUNCTIONING AS A COMPONENT OF A WHOLE HOUSE VENTILATION SYSTEM, MUST BE CONTROLLED BY A HUMIDITY CONTROL.

LEGEND

 XXXXXXX 777777777777777777777777	ONE HOUR RATED STC 50 (HALLWAY AND PARTITION WALLS)
	TWO HOUR RATED (SHAFT WALL)
	TWO HOUR RATED (CONCRETE BLOCK WALL) PROPERTY LINE
	HARD WIRED SMOKE DETECTOR W/ BATTERY BACK-UP
VKL	MECHANICAL VENT, 7 1/2 AIR CHANGE PER HOUR, SHALL BE ENERGY STAR COMPLIANT W/HUMIDISTAT AND BE DUCTED TO TERMINATE TO THE OUTSIDE OF THE BUILDING.
\Rightarrow	GROUND- FAULT CIRCUIT-INTERUPTER
*	TEMPERED GLASS
- FX-I	OUTSIDE MAXIMUM 14' LENGTH W/TWO 4" MIN. METAL DRYER VENT, DIRECTLY TO ELBOWS FROM DRYER
48"	CARBON MONOXIDE DETECTOR
	48"X30" CLEAR FLLOR SPACE

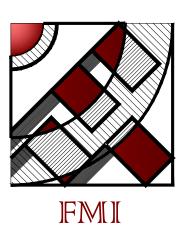

Design & eng. CONSTRUCTION.

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PROJECT:

5879 Crenshaw Blvd Los Angeles, CA 90043

SHEET TITLE:


THIRD FLOOR PLAN

REVISION: NO. DATE BY - - -

SCALE : DESIGN & DRAWN : DATE : JOB NUMBER :

1/8"=1'-0" FMI 02.11.21

A-2.2

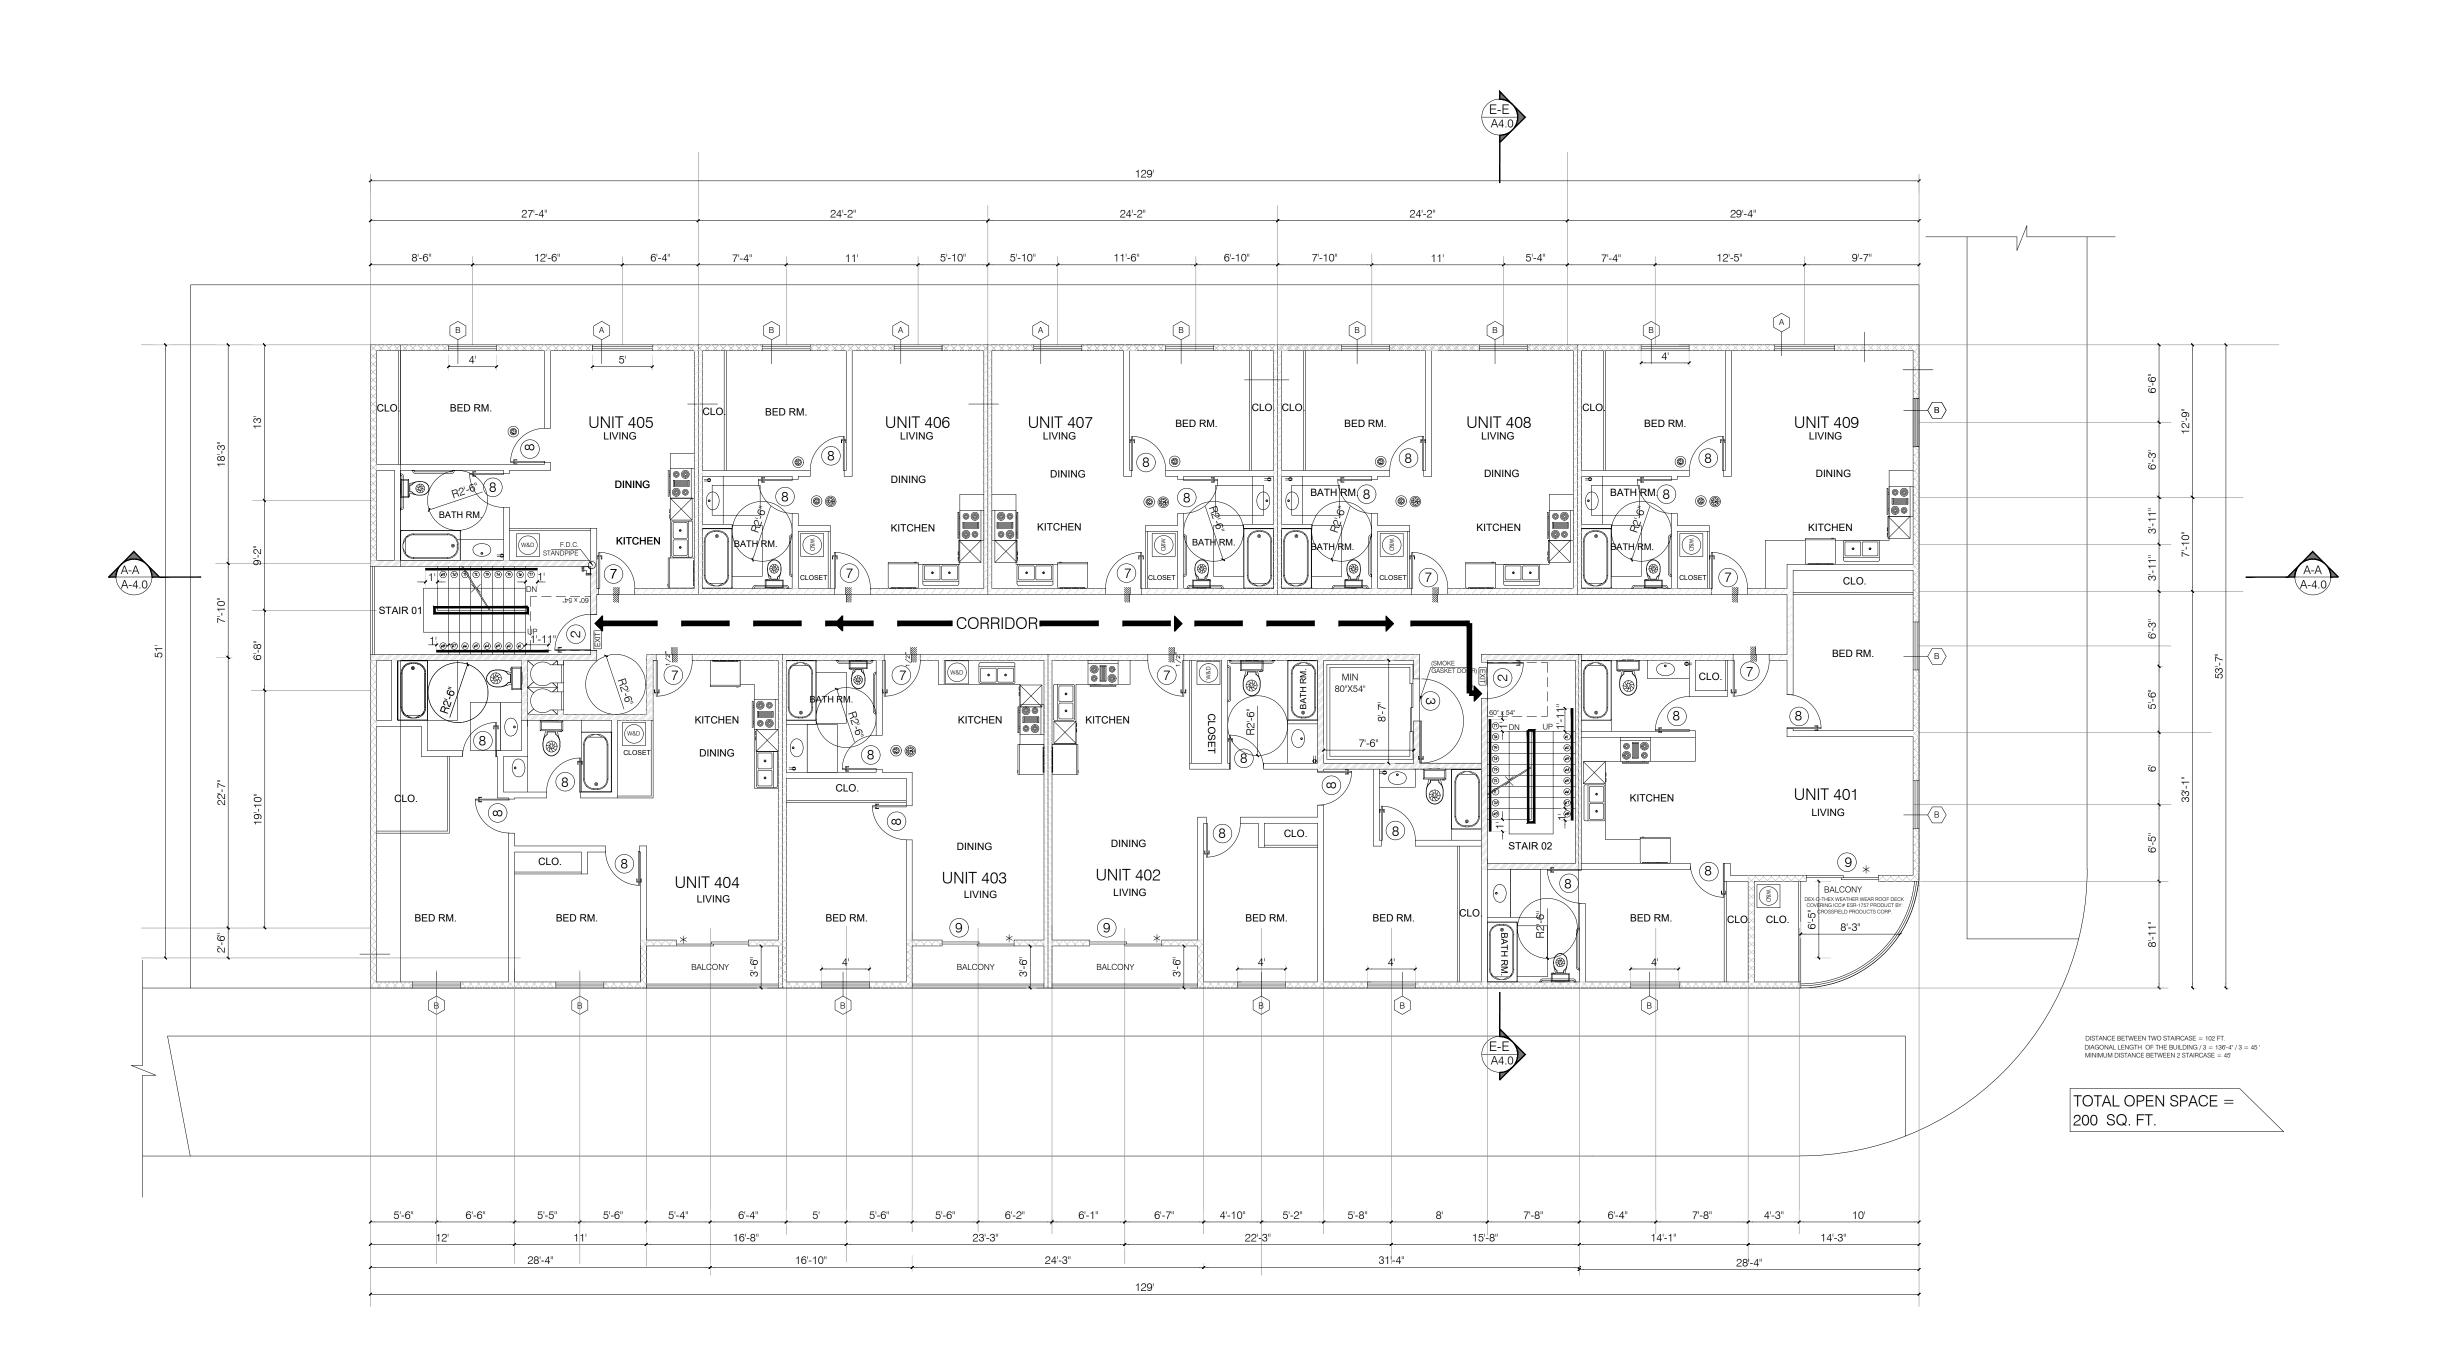

FOURTH FLOOR PLAN SCALE: 1/8"= 1'-0"

FIRE EXTINGUISHERS

- PORTABLE FIRE EXTINGUISHERS SHALL BE PROVIDED: (SIZE AND DISTRIBUTION SHALL BE IN ACCORDANCE WITH SEC. 906.1-906.4).

W/D:

- WASHER AND DRYE SHALL BE FRONT LOAD (if conter is provided, shall be at 34" max. height with 27" min. knee clear at 19" min. deep, typical) COMPLY WITH CODE SECTION (1127.A.10)

EXIT ACCESS

- EXIT ACCESS DOORWAYS, STAIRWAYS OR RAMPS SHALL BE PLACED A DISTANCE APART> $(\frac{1}{2})$ THE LENGTH OF THE OVERALL DIAGONAL OF THE AREA TO BE SERVED (CBC 1007.1.1) ALLOWABLE: 131' / 2 = 65.5'PROPOSED: 64'-0"

NOTES:

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- KITCHEN COUNTER MATERIAL IS GRANITE STONE W/ 36" HEIGHT. - ALL BATHROOM VANITIES COUNTER SHALL BE 36" HEIGHT.

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3. SHOWER SHALL COMPLY WITH SECTION 1134A.6. 4. WATER CLOSET SHALL COMPLY WITH SECTION 1134A.7. 5. LAVATORIES VANITIES, MIRRORS AND TOWEL FIXTURES SHALL COMPLY

WITH SECTION 1134A.8.

2. BATHTUBS SHALL COMPLY WITH SECTION 1134A.5.

6. WHERE BOTH A SHOWER AND TUB ARE PROVIDED IN THE BATHROOM, AT LEAST ONE SHALL BE MADE ACCESSIBLE.

7. WHEN TWO OR MORE LAVATORIES ARE PROVIDED AT LEAST ONE SHALL BE MADE ACCESSIBLE AND COMPLY WITH SECTION 1134A.8.

8. BATHROOM SHALL PROVIDED WITH AN ACCESSIBLE ROUTE INTO AND THROUGH THE BATHROOM.

9. IF A DOOR IS PROVIDED, IT SHALL COMPLY WITH THE REQUIREMENTS OF SECTION 1132.5.

10. A MIN. 18-INCH (457MM) CLEAR MANEUVERING SPACE SHALL BE PROVIDED ON THE SWING OF THE DOOR AT THE STRIKE EDGE OF THE DOOR

11. SWITCHES, OUTLETS AND CONTROLS SHALL COMPLY WITH SECTION 1142A. 12. REINFORCED WALLS TO ALLOW FOR THE FUTURE INSTALLATION OF GRAB BARS AROUND THE TOILET, TUB AND SHOWERS SHALL COMPLY WITH SECTION 1134A.5 FOR BATHTUBS, 1134A6 FOR SHOWERS AND 1134A.7 FOR WATER CLOSET. GRAB BAR SHALL COMPLY WITH SECTION 1127A.4 AND 1127.2.2. ITEM 4.


GRN NOTES:

- EXHAUST FAN SHALL BE ENERGY STAR COMPLIANT AND BE DUCTED TO TERMINATE TO THE OUTSIDE OF THE BUILDING. - EXHAUST FAN NOT FUNCTIONING AS A COMPONENT OF A WHOLE HOUSE VENTILATION SYSTEM, MUST BE CONTROLLED BY A HUMIDITY CONTROL.

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30"

	WALL
	ONE HOUR RATED STC 50 (HALLWAY AND PARTITION WALLS)
	TWO HOUR RATED (SHAFT WALL)
7777	TWO HOUR RATED (CONCRETE BLOCK WALL)
	PROPERTY LINE
	HARD WIRED SMOKE DETECTOR W/ BATTERY BACK-UP
	MECHANICAL VENT, 7 1/2 AIR CHANGE PER HOUR, SHALL BE ENERGY STAR COMPLIANT W/HUMIDISTAT AND BE DUCTED TO TERMINATE TO THE OUTSIDE OF THE BUILDING.
⇒	GROUND- FAULT CIRCUIT-INTERUPTER
*	TEMPERED GLASS
\bigotimes	OUTSIDE MAXIMUM 14' LENGTH W/TWO 4" MIN. METAL DRYER VENT, DIRECTLY TO ELBOWS FROM DRYER
48"	CARBON MONOXIDE DETECTOR
	48"X30" CLEAR FLLOR SPACE

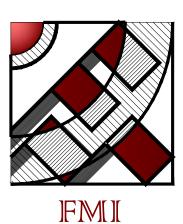

Design & eng. CONSTRUCTION.

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OWNER:

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PROJECT:

5879 Crenshaw Blvd Los Angeles, CA 90043

SHEET TITLE:

FOURTH FLOOR PLAN

REVISION: NO. DATE BY - - -

SCALE : DESIGN & DRAWN : DATE : JOB NUMBER :

1/8"=1'-0" FMI 02.11.21

A-2.3